PROPOSED NEW LEURA MALL HOTEL AT 198-204 LEURA MALL, LEURA NSW 2780



Dial Before You Dig should be contacted prior to any excavation on site. Trade Mark of Before You Dig Services Ltd. Used under license.

CONCEPT STORMWATER DESIGN PLANS

LECEND	
LEGEND	
	STORMWATER LINE
SSD	SUBSOIL LINE
SWRM	STORMWATER RISING MAIN
———е——	EXISTING STORMWATER LINE
swsw	AUTHORITY STORMWATER LINE
s	AUTHORITY SEWER LINE
——— w ———	AUTHORITY WATER LINE
—— G —— G ——	AUTHORITY GAS LINE
	AUTHORITY ELECTRICITY LINE
— — UE— —	AUTHORITY UNDERGROUND ELECTRICITY LINE
—F0—F0—F0—	AUTHORITY FIBRE OPTIC LINE
TEL	AUTHORITY COMMS LINE
	FENCE LINE
	GRATED SURFACE INLET PIT
	GRATED SURFACE INLET PIT WITH ENVIROPOD INSERT
	JUNCTION PIT
	KERB INLET PIT
	EXISTING GRATED SURFACE INLET PIT
	GRATED TRENCH DRAIN
L×7	EXISTING JUNCTION PIT
	EXISTING KERB INLET PIT
eTEL	EXISTING TELSTRA PIT
⊞ eHYD	EXISTING HYDRANT
⊠ eSV	EXISTING STOP VALVE
□ eGAS	EXISTING GAS VALVE
O ePP	EXISTING POWER POLE
¤ eBT	EXISTING BOUNDARY TRAP

LEGEND	
eSMH	EXISTING SEWER MANHOLE
OFP	OVERLAND FLOW PATH
RWO∅	RAINWATER OUTLET
CO Ø	CLEAR OUT POINT
DDO Ø	DISH DRAIN OUTLET
PD ∅	PLANTER DRAIN
3	CAPPING
(1.01)	PIT TAG/NUMBER
RH 🔯	RAINHEAD
•	DOWNPIPE DROP
X	NON RETURN VALVE
)-(WALL PENETRATION
DP●	DOWNPIPE
DP L	DOWNPIPE + SPREADER
-	WARNING LIGHT
0.00 •	SPOT LEVELS
Δ	BENCHMARK

DD

DDO

DGS

HYD

KIP

KO

OSD

RL

RW

SJ

SMH

SW

SWP

SWRM

TOW

UPVC

TYP

SEWER MAN HOLE

STORMWATER SUMP

STORMWATER RISING MAIN

UNPLASTICISED POLYVINYL

UNLESS NOTED OTHERWISE

WEAKENED PLANE JOINT

FIRST FLUSH DEVICE

STORMWATER

STOP VALVE TOP OF KERB

TOP OF WALL TOP WATER LEVEL TANGENT POINT

CHLORIDE

TYPICAL

DP

DRAINAGE NOTES: ABBREVIATIONS: ALL PIPES TO BE LAID ON 75mm SAND BED WITH THE BARRELS FULLY DIAMETER SUPPORTED CALIFORNIA BEARING RATIO CHAINAGE 100mm AND 150mm DIAMETER PIPES TO BE LAID ON MINIMUM 1% GRADE **CENTER LINE** CLEAR OUT MINIMUM DEPTH OF COVER FOR PIPES NOT SUBJECT TO VEHICULAR LOADING DISH DRAIN TO BE 300mm DISH DRAIN OUTLET DOWELLED EXPANSION JOINT ALL DRAINAGE PIPES LAID UNDER PAVEMENT SHALL BE REINFORCED DENSE GRADED BASECOURSE CONCRETE WITH RUBBER RING JOINTS DENSE GRADED SUB-BASE DOWNPIPE BACKFILL TRENCHES WITH COMPACTED SAND OR APPROVED AGGREGATE **EXISTING** FINISHED FLOOR LEVEL GRATED TRENCH DRAIN ALL PITS TO HAVE 600x600mm INTERNAL DIMENSIONS (U.N.O.) GRATED SURFACE INLET PIT HYDRANT SILT ARRESTORS TO HAVE 900x900mm INTERNAL DIMENSIONS ISOLATING JOINT INTEGRAL KERB HEAVY DUTY GRATES AND COVERS ARE TO BE PROVIDED IN TRAFFICABLE INVERT LEVEL INTERSECTION POINT KERB INLET PIT PIT GRATE TO BE TYPE WELDLOK OR APPROVED EQUIVALENT KERB ONLY **KERB & GUTTER** ALL PITS SHALL BE PROVIDED WITH A LOCKING CLIP KERB RETURN LONGITUDINAL SECTION ALL PITS SHALL BE MAINTAINED REGULARLY NATURAL GROUND LEVEL OVERLAND FLOW PATH TOP OF BENCHING SHALL BE TO THE HALF OF THE OUTLET PIPE DIAMETER ON-SITE DETENTION RADIUS MAXIMUM FRONT ENTRY PIPE:-REINFORCED CONCRETE PIPE STRAIGHT ENTRY - Ø750 **ROLL KERB & GUTTER** SKEW ENTRY 45° - Ø525 REDUCED LEVEL **RETAINING WALL** Ø100 SUBSOIL DRAINAGE PIPE 3000mm LONG WRAPPED IN FABRIC SOCK TO BE RAINWATER TANK PROVIDED ADJACENT TO INLET PIPES SAWN CONTROL JOINT

20MPa AT 28 DAYS

COMPRESSIVE STRENGTH for CAST IN SITU CONCRETE TO BE A MINIMUM OF

PROVIDE CLEANING EYES TO ALL DOWNPIPES NOT DIRECTLY CONNECTED TO

ISOLATED JOINTS TO BE PROVIDED TO ISOLATE CONCRETE PAVEMENTS FROM

ALL TRENCH GRATES PROVIDED SHALL HAVE A MINIMUM CLEAR WIDTH OF

STORMWATER DRAINAGE CONNECTIONS TO THE MAIN SYSTEM SHALL BE TO

THE REQUIREMENTS AND THE SATISFACTION OF LOCAL COUNCIL

DRAWING REGISTER							
NUMBER	NAME	REVISION					
SW-01	COVER SHEET & SPECIFICATIONS	F					
SW-02	EROSION & SEDIMENT CONTROL PLAN	F					
SW-03	BASEMENT PLAN	F					
SW-04	GROUND FLOOR PLAN	F					
SW-05	OSD & DRAINS MODEL RESULTS	F					
SW-06	WSUD & MUSIC MODEL CATCHMENT PLAN	F					
SW-07	WSUD & MUSIC MODEL RESULTS	F					
SW-08	DETAILS - SHEET 1	F					
SW-09	DETAILS - SHEET 2	F					

STORMWATER PIPE BEDDING/PAVING

WHERE TRENCH BASE IS ROCK A MINIMUM OF 75mm BEDDING TO BE PROVIDED UNDER PIPE COLLARS.

STORMWATER PIPE BEDDING DETAIL TO BE IN ACCORDANCE WITH LOCAL COUNCIL REQUIREMENTS. BEDDING DETAILS TO BE CONFIRMED UPON

FOOTPATH REINSTATEMENT NOTES:

EXCAVATION & PRIOR TO INSTALLATION OF PIPEWORK.

REMOVE ALL SAND FILL WITHIN THE FOOTPATH AREA TO THE EXISTING SUBGRADE.

SUPPORT ALL AUTHORITY SERVICES TO STRUCTURAL ENGINEERS DETAILS DURING EXCAVATION.

REINSTATE FOOTPATH SUBGRADE.

THE CONTRACTOR SHALL PROVIDE CERTIFICATION OF COMPACTION FROM A NATA REGISTERED TESTING AUTHORITY. MINIMUM THREE TESTS PER LAYER AS FOLLOWS:

SELECT FILL 95% MODIFIED SELECT FILL (LESS THAN 300mm 98% MODIFIED BELOW BASE COURSE)

100% MODIFIED BASE COURSE

EROSION & SEDIMENT CONTROL NOTES:

PROVIDE SILT FENCE/HAY BAIL BARRIERS TO THE LOW SIDE OF ALL EXPOSED EARTH EXCAVATIONS (TYPICAL).

ISOLATE EXISTING STORMWATER PITS WITH HAY BALES TO FILTER ALL INCOMING FLOWS.

DO NOT STOCK PILE EXCAVATED MATERIAL ON THE ROAD WAY.

SURVEY

THE EXISTING SITE CONDITIONS SHOWN ON THE FOLLOWING DRAWINGS HAVE BEEN INVESTIGATED BY RICHARD HOGAN & CO P/L, BEING REGISTERED SURVEYORS. THE INFORMATION IS SHOWN TO PROVIDE A BASIS FOR DESIGN. GEBA CONSULTING DOES NOT GUARANTEE THE ACCURACY OR COMPLETENESS OF THE SURVEY BASE OR ITS SUITABILITY AS A BASIS FOR CONSTRUCTION


SHOULD DISCREPANCIES BE ENCOUNTERED DURING CONSTRUCTION BETWEEN THE SURVEY DATA AND ACTUAL FIELD DATA, CONTACT GEBA CONSULTING.

ADOPT DATUM PM 41036 RL:962.066 (A.H.D) AS PER RICHARD HOGAN & CO P/L. REFERENCE-17892.


~ ebi	2/11/11/10 2001/12/11/11/11
DEPTH AND LOCATION CONTRACTOR TO C. APPLICATION AND E	ON PLAN ARE INDICATIVE, EXACT ON TO BE CONFIRMED ONSITE. ARRY OUT DIAL BEFORE YOU DIG ENGAGE A REGISTERED SURVEYOR TO ING SERVICES PRIOR TO ANY WORK TE.

GEBA Consulting Pty Ltd Suite 1503, 99 Bathurst Street, Sydney NSW 2000 ABN 76 604 068 013

W : www.gebaconsulting.com.au E : info@gebaconsulting.com.au P: 0424 137 297

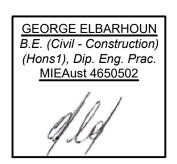



Client MR. MICHAEL PETROVIC
Architect PTI ARCHITECTS
Project PROPOSED NEW LEURA MALL HOTEL
Address 198-204 LEURA MALL, LEURA NSW 2780

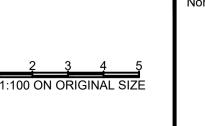


rthpoint	
	7

Description FOR DA SUBMISSION TO COUNCIL	Des. G.E.	Chk. G.E.	App. G.E.	Rev. A	Date 12.02.20	DEVELO	PMENT A	PPLICAT	ION (DA)
FOR DA SUBMISSION TO COUNCIL	G.E.	G.E.	G.E.	В	19.02.20		remains the p		
AMENDED TO WATER NSW COMMENTS	G.E.	G.E.	G.E.	С	17.06.20	and must not be written or reproduced without consent			
AMENDED AS PER COUNCIL COMMENTS	G.E.	G.E.	G.E.	D	09.11.20	COVER SHEET & SPECIFICATIONS			
FOR SUBMISSION	J.S.	G.E.	G.E.	Е	29.04.22	Project number	Drawing number	Original Size	Scale
FOR APPROVAL	J.S.	G.E.	G.E.	F	17.08.22	GC20010	SW01	A1	1:100

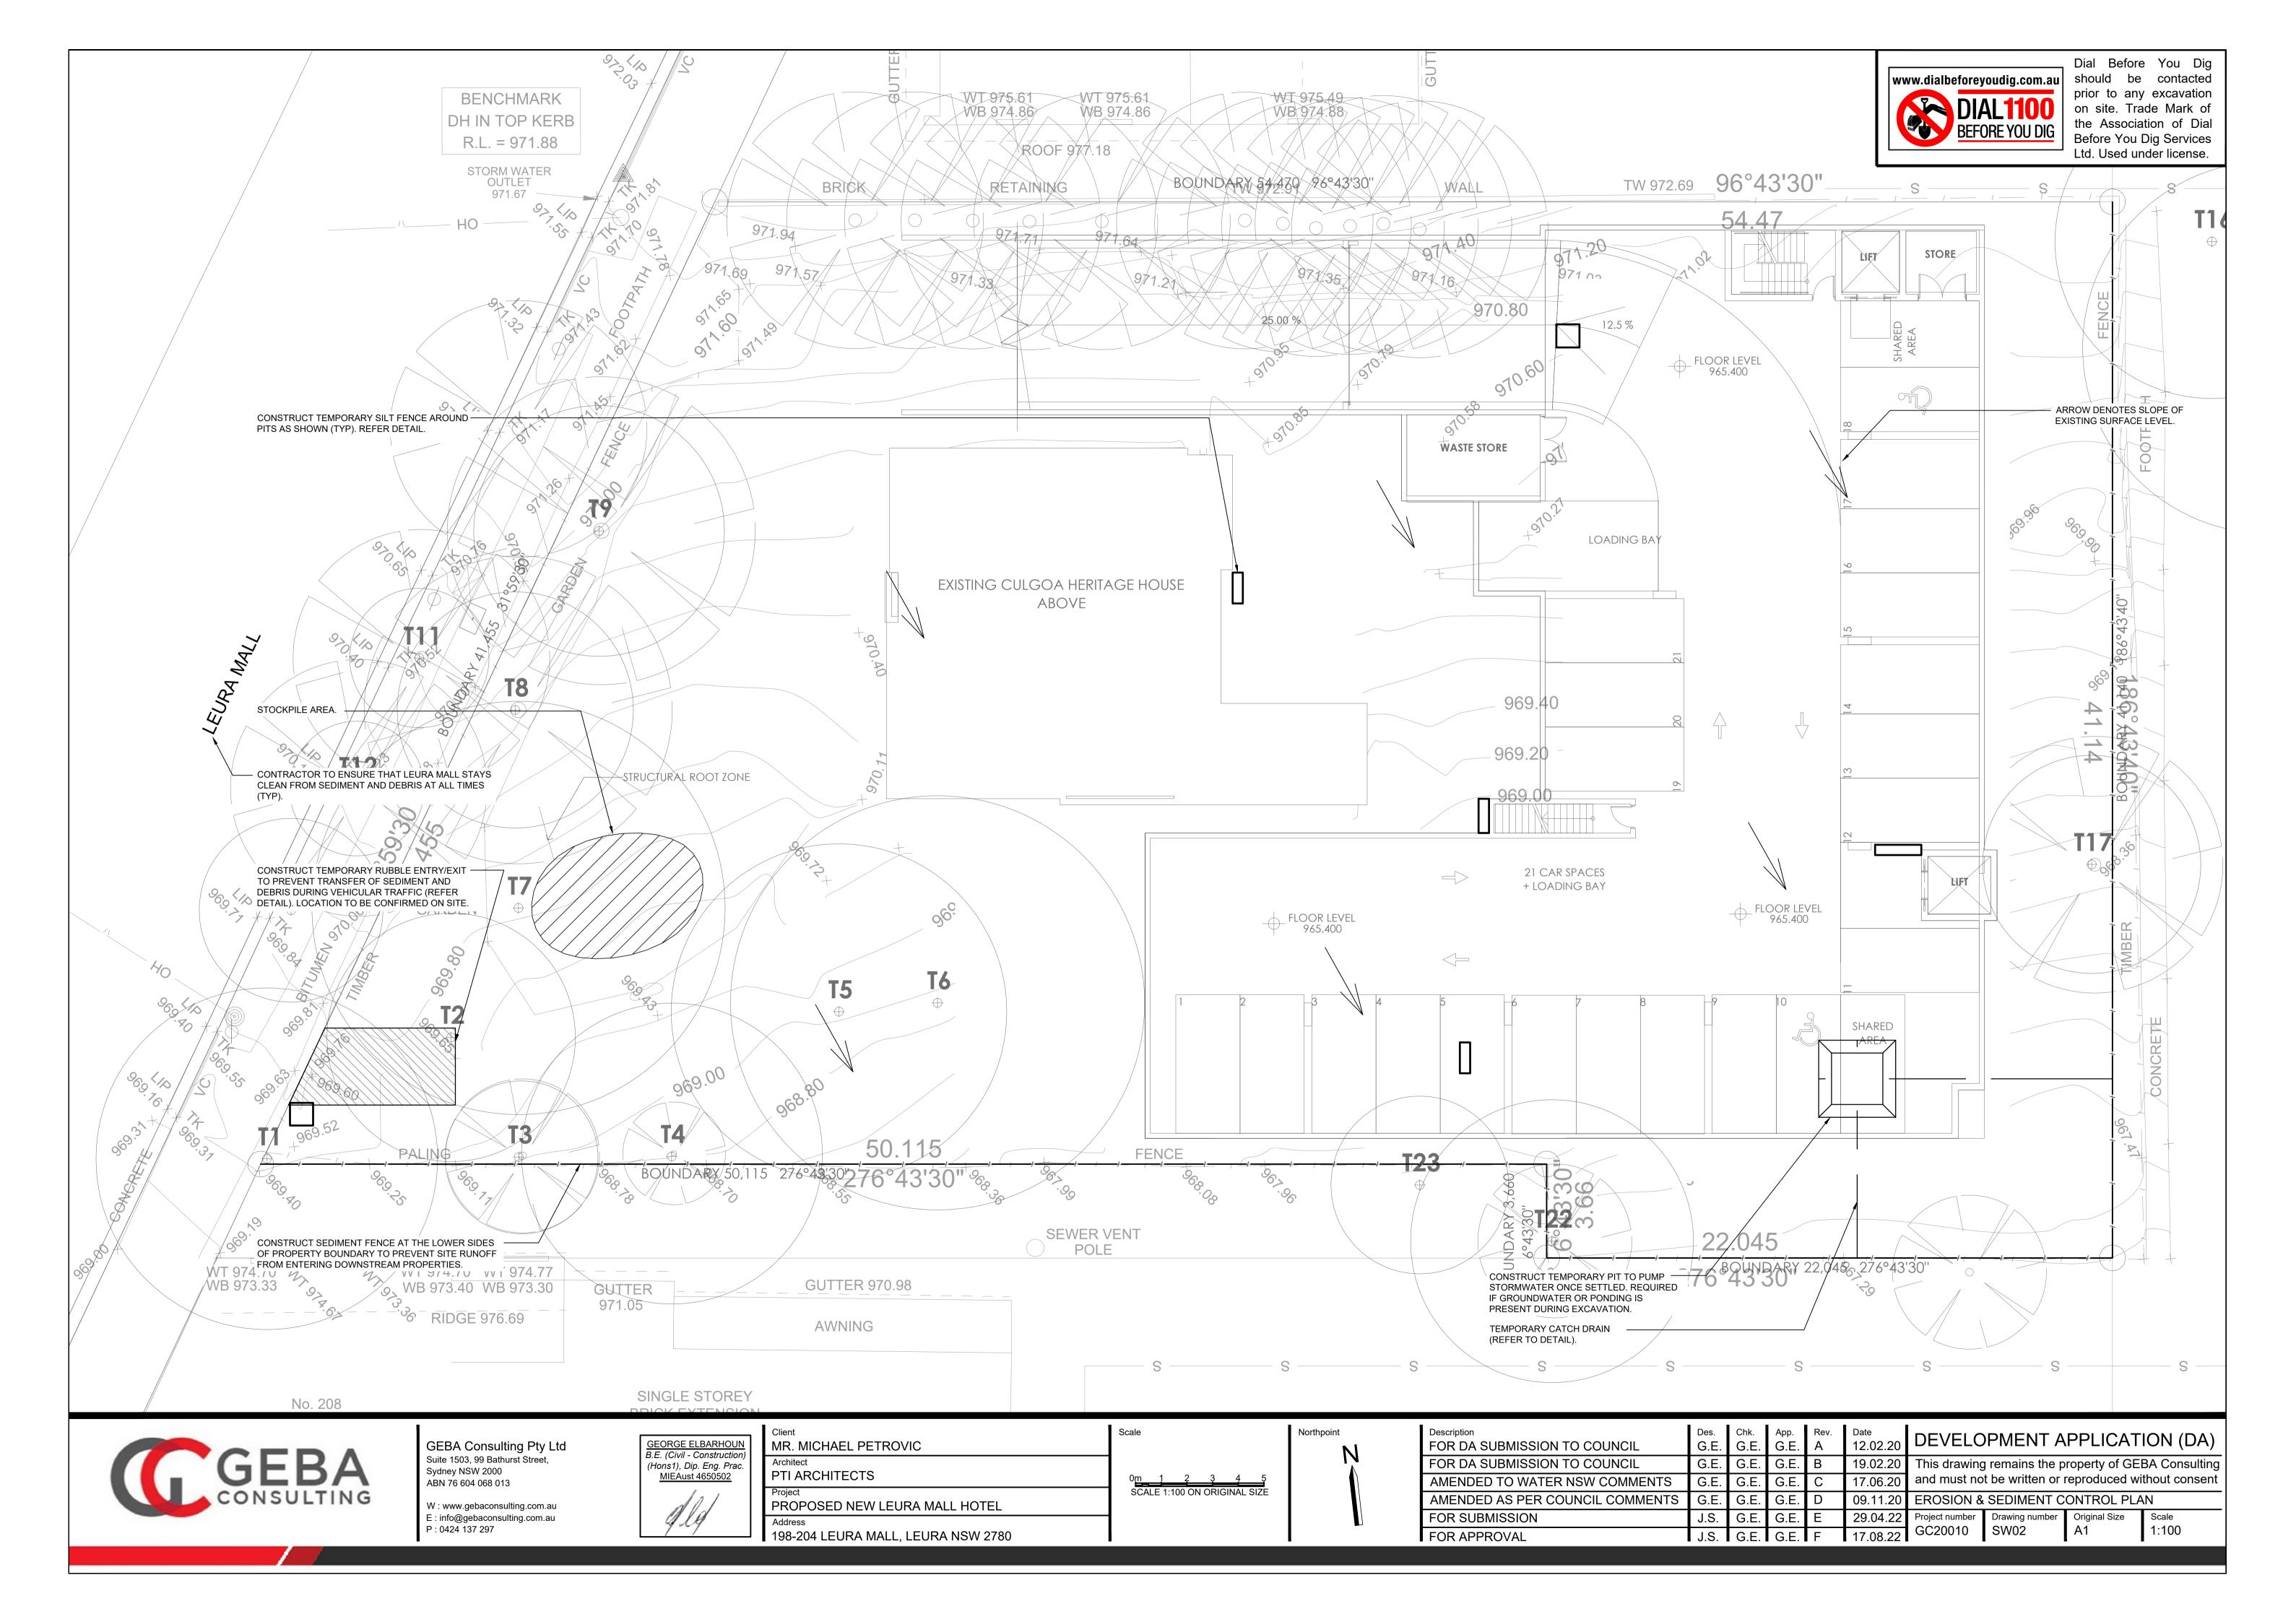

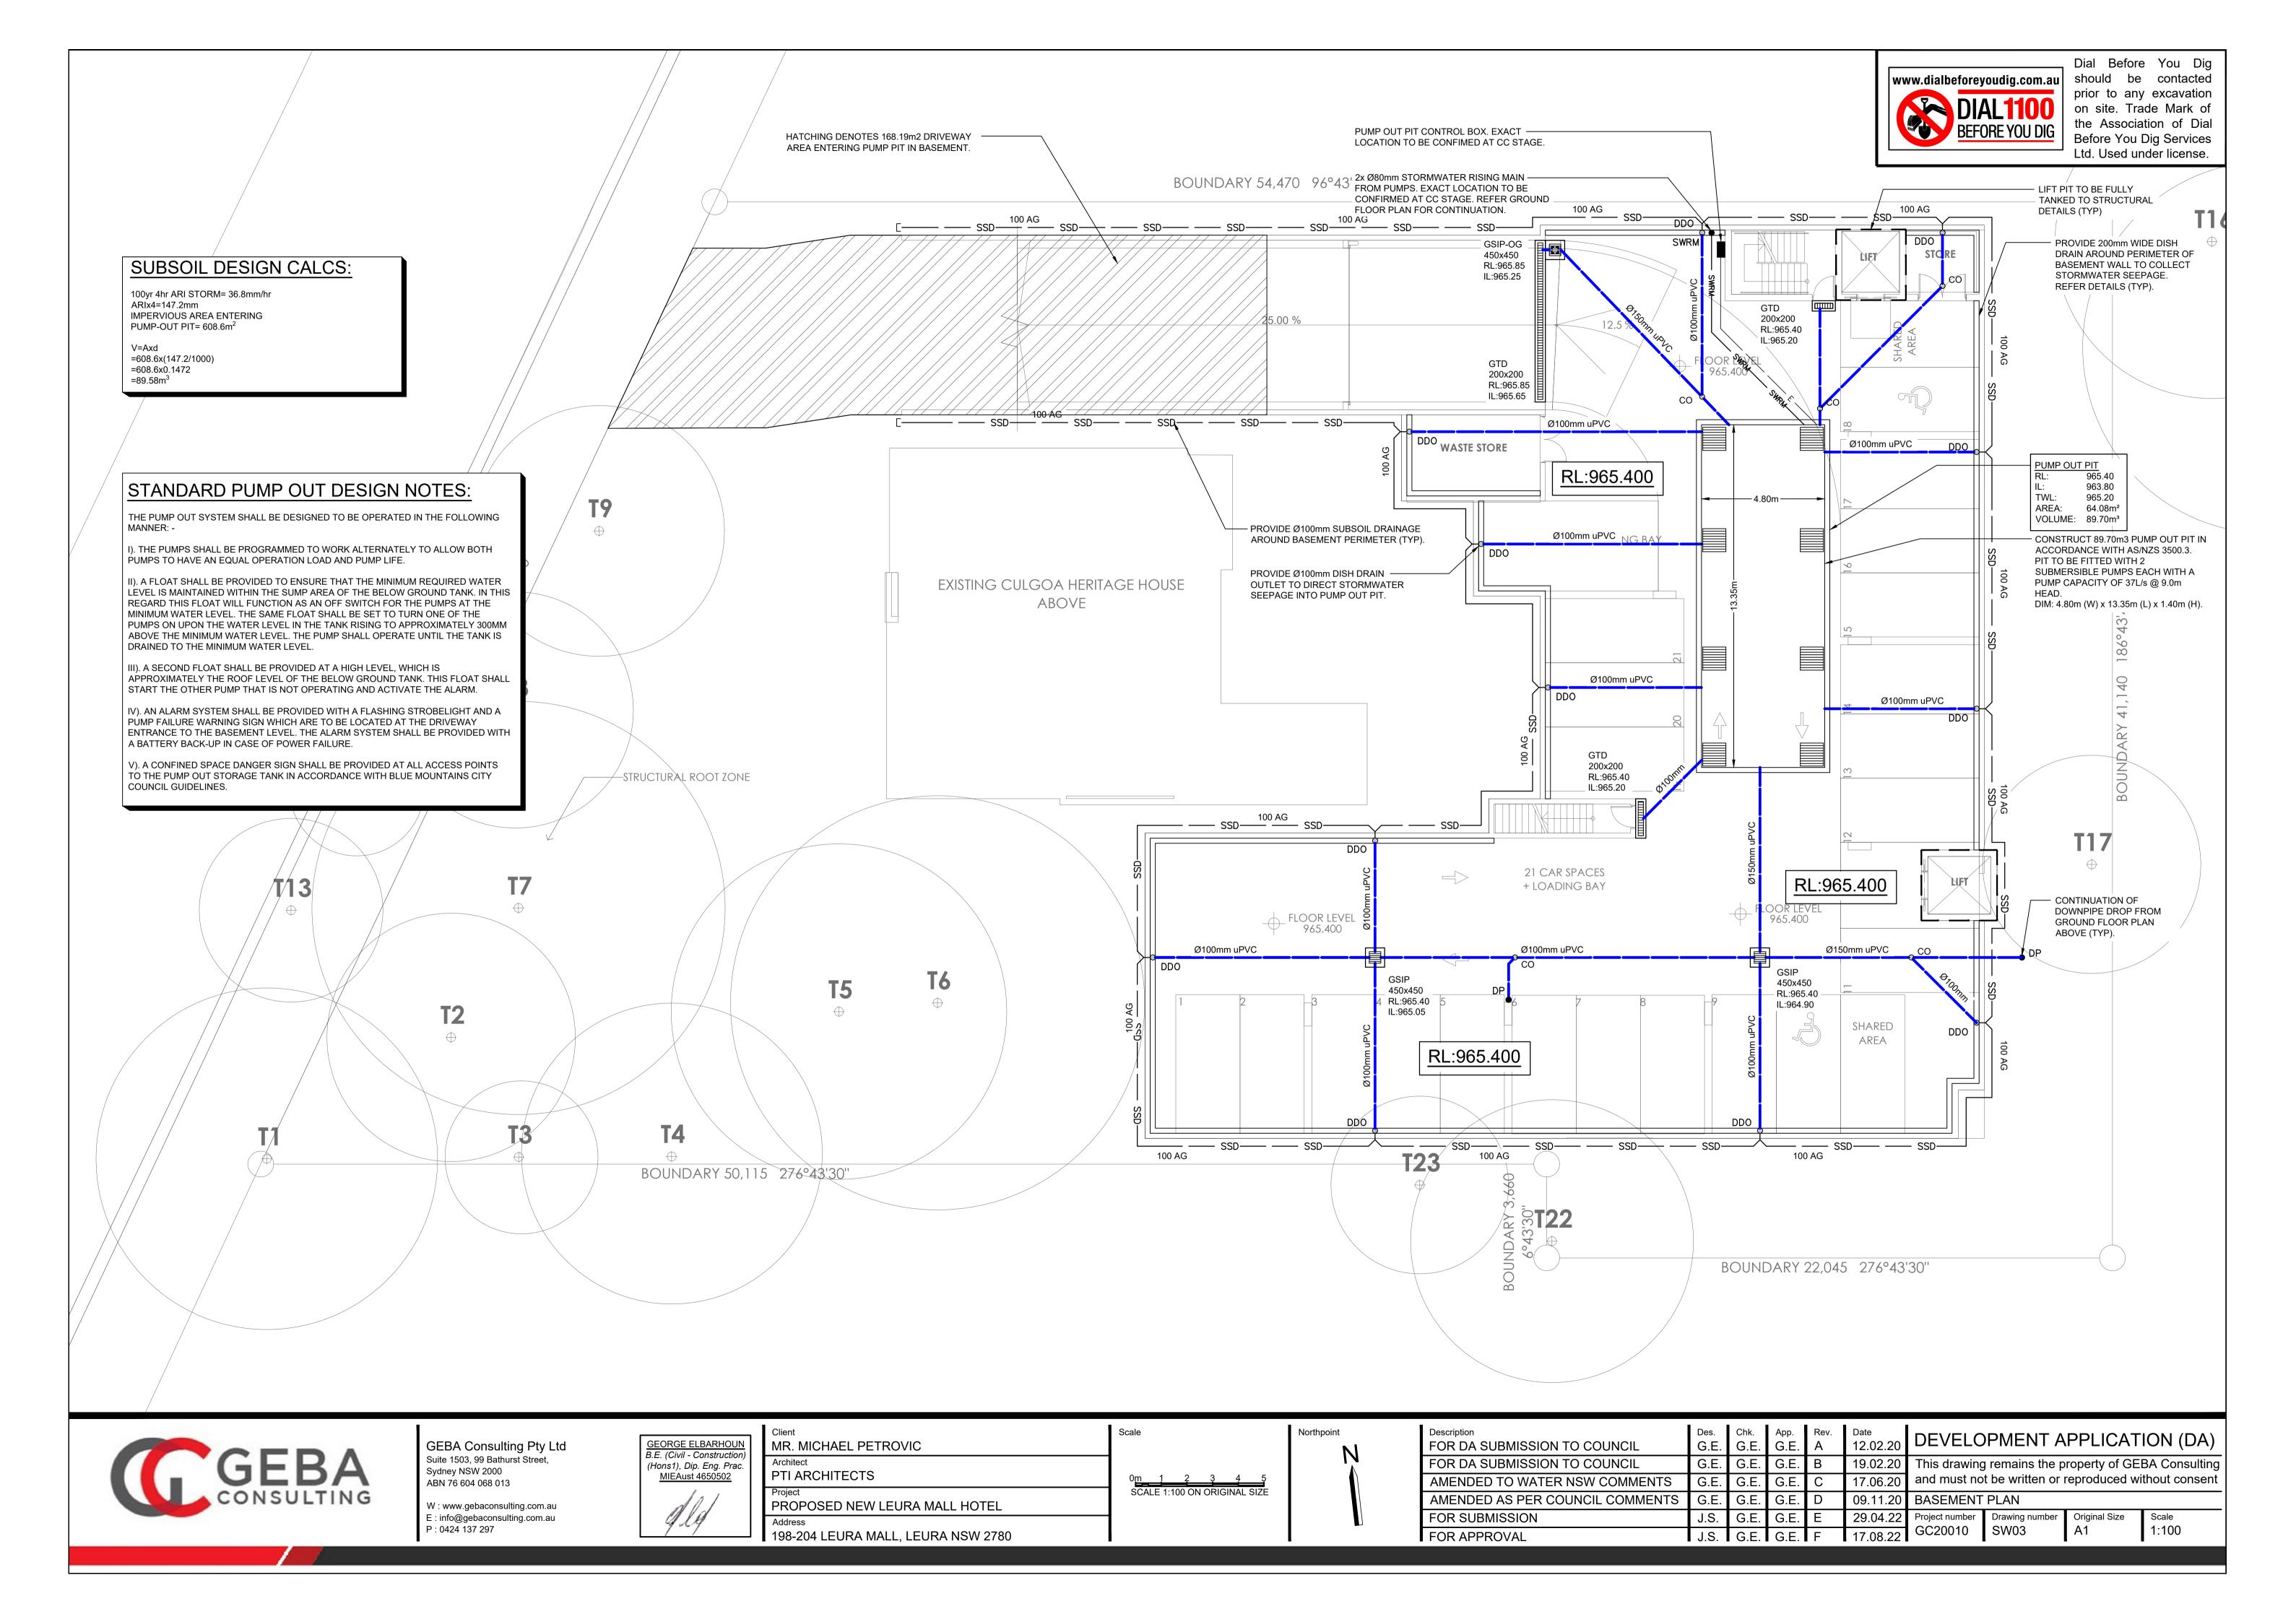

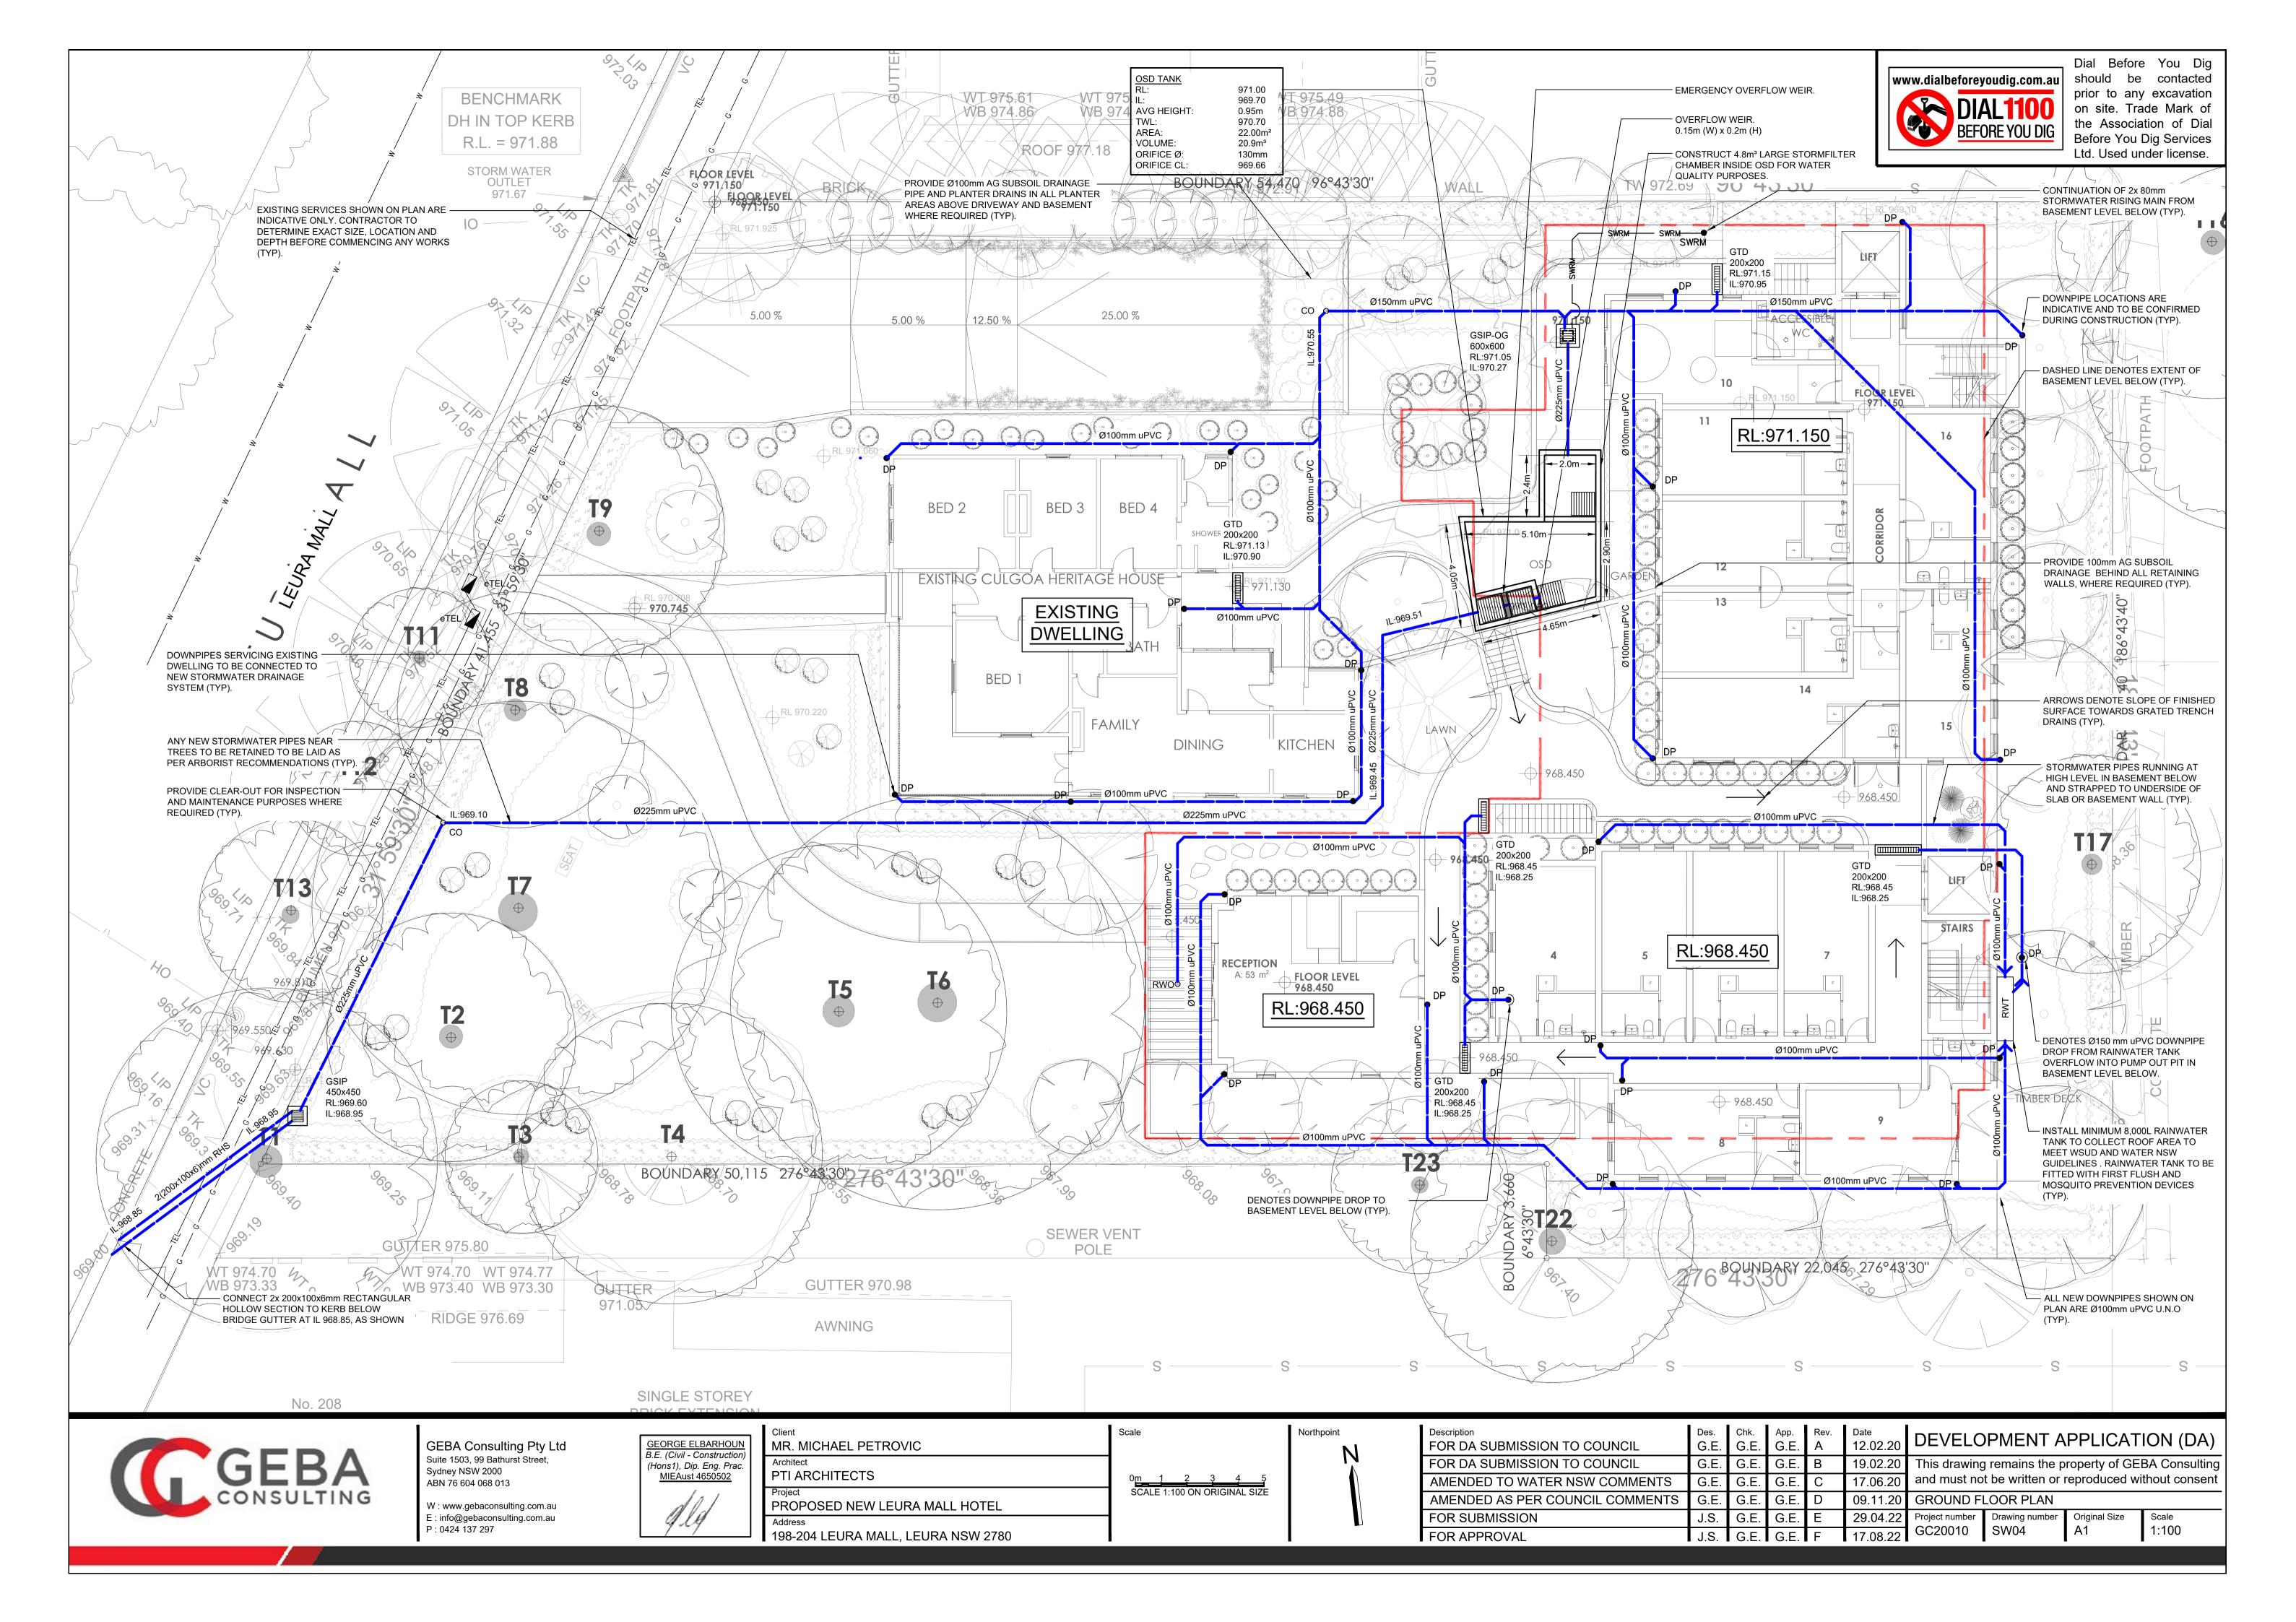



Dial Before You Dig should be contacted prior to any excavation on site. Trade Mark of the Association of Dial Before You Dig Services Ltd. Used under license.

RWT NOTES:

RAINWATER TANK TO SIZED AT 1000L PER 100m² INCREASE IN IMPERVIOUS AREA, AS PER SECTION C6.1.3, CONDITION C2 (B) OF THE BLUE MOUNTAINS DCP, AS PER LEC CASE 2021/00307840

1244.95- 790.3 = 454.65 m² INCREASE IN IMPERVIOUS AREA.

THEREFORE A MINIMUM OF 4,600L RAINWATER TANK STORAGE IS REQUIRED TO MEET DCP REQUIREMENTS

MINIMUM 8,000L RAINWATER TANK TO BE PROVIDED TOP MEET WSUD AND WATERNSW GUIDELINES.

DESIGN NOTES:

THE SITE IS LOCATED IN BLUE MOUNTAINS CITY COUNCIL.

SITE AREA = 2,453m².

SITE IS LOCATED IN THE 'SYDNEY DRINKING WATER CATCHMENTS'.

THEREFORE, PROVIDE WATER SENSITIVE URBAN DESIGN (WSUD) IN ACCORDANCE WITH WATER-NSW GUIDELINES.

ON-SITE STORMWATER DETENTION (OSD) IS REQUIRED IN ACCORDANCE WITH BMCC DCP2015 - PART C6.2.

THE OSD STORAGE SYSTEM WILL BE BELOW GROUND.

OSD WAS DESIGNED USING DRAINS. THE RESULTS ARE SHOWN BELOW:

DRAINS MODELLING PARAMETERS:

THE STORAGE CAPACITY AND PERMISSIBLE SITE DISCHARGE OF THE OSD WAS CALCULATED THROUGH A DRAINS MODEL WITH REGARDS TO BLUE MOUNTAINS CITY COUNCIL DCP REQUIREMENTS LISTED BELOW;

POST-DEVELOPMENT FLOWS RESTRICTED TO THE PRE-DEVELOPMENT FLOWS (IN ACCORDANCE WITH COUNCIL DCP).

PRE-DEVELOPMENT IMPERVIOUS CATCHMENT = 790.3m2 POST-DEVELOPMENT IMPERVIOUS CATCHMENT = 1244.95m2

TIME OF CONCENTRATION = 5min(s)

ALL STORMWATER PIPES SHOWN ON PLAN ARE Ø100mm uPVC U.N.O.

PROVIDE CLEAR OUTS FOR INSPECTION AND MAINTENANCE PURPOSES, WHERE REQUIRED.

OSD DESIGN PARAMETERS:

1. THE PRE/POST-DEVELOPMENT IMPERVIOUS AREA WAS MEASURED THROUGH


2. THE POST-DEVELOPMENT IMPERVIOUS AREA WAS DESIGNATED A VALUE OF 100.0% FOR A MORE ACCURATE VALUE AND TO REPLICATE THE PROPOSED IMPERVIOUS AREA FOR SIZING OSD ON DRAINS.

3. THE RAINFALL DATA WAS CALCULATED AND OBTAINED BY THE BUREAU OF METEOROLOGY, AUSTRALIA FOR THE RESPECTIVE LOCATION


OF THE SITE.

- LATITUDE: 33.725 (S) - LONGITUDE: 150.325 (E)

OSD - DRAINS MODEL

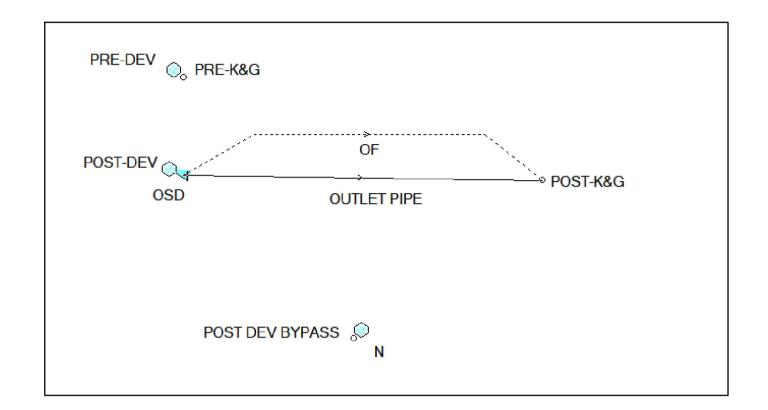

OSD - DRAINS RESULT

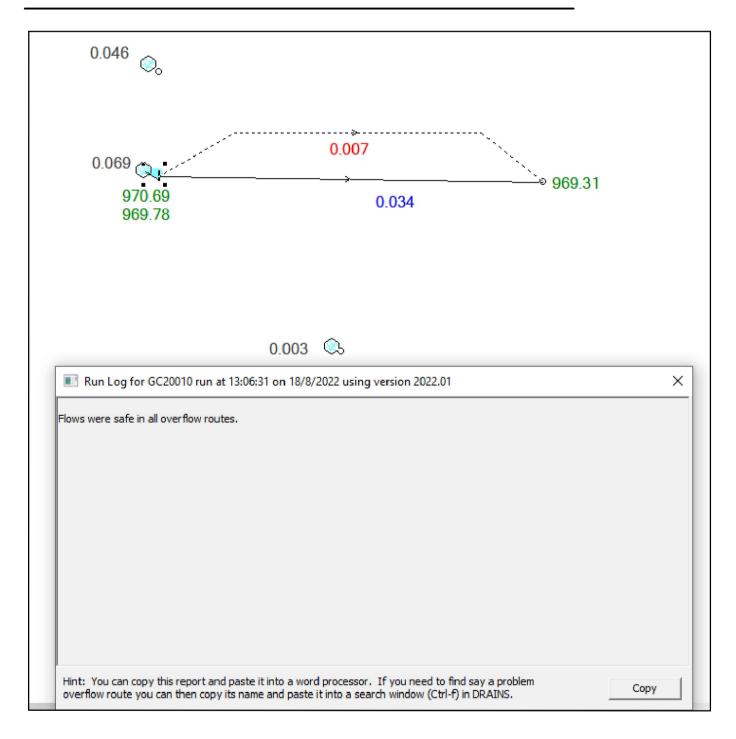


POST-DEVELOPMENT OSD REQUIREMENTS:

LOT AREA (m²)	PRE-DEV IMPERVIOUS (m²)	POST-DEV IMPERVIOUS (m²)	STORM (YR)	PRE-DEV FLOW (m³/s)	POST-DEV FLOW (m³/s)	PIPE OUTFLOW (m³/s)	WEIR OUTFLOW (m³/s)	OSD BYPASS (m³/s)	TOTAL PSD (m³/s)	OSD VOLUME (m³)
2,453	790.3	1244.95	5	0.027	0.043	0.025	0.000	0.002	0.027	
			20	0.036	0.060	0.030	0.000	0.003	0.033	20.90
			100	0.046	0.072	0.034	0.007	0.003	0.044	




GEBA Consulting Pty Ltd Suite 1503, 99 Bathurst Street, Sydney NSW 2000 ABN 76 604 068 013


W : www.gebaconsulting.com.au E : info@gebaconsulting.com.au P: 0424 137 297

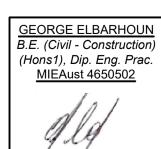

¬	Client
	MR. MICHAEL PETROVIC
	Architect PTI ARCHITECTS
	Project PROPOSED NEW LEURA MALL HOTEL
	Address 198-204 LEURA MALL, LEURA NSW 2780

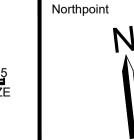


Description FOR DA SUBMISSION TO COUNCIL	Des. G.E.	Chk. G.E.	App. G.E.	Rev. A	Date 12.02.20	DEVELO	PMENT A	PPLICAT	ION (DA)
FOR DA SUBMISSION TO COUNCIL	G.E.	G.E.	G.E.	В	19.02.20	This drawing remains the property of GEBA Consulting			
AMENDED TO WATER NSW COMMENTS	G.E.	G.E.	G.E.	С	17.06.20	and must not be written or reproduced without consent			
AMENDED AS PER COUNCIL COMMENTS	G.E.	G.E.	G.E.	D	09.11.20	OSD & DRAINS MODEL RESULTS			
FOR SUBMISSION	J.S.	G.E.	G.E.	Е	29.04.22	Project number	Drawing number	Original Size	Scale
OR APPROVAL	J.S.	G.E.	G.E.	F	17.08.22	GC20010	SW05	A1	1:100

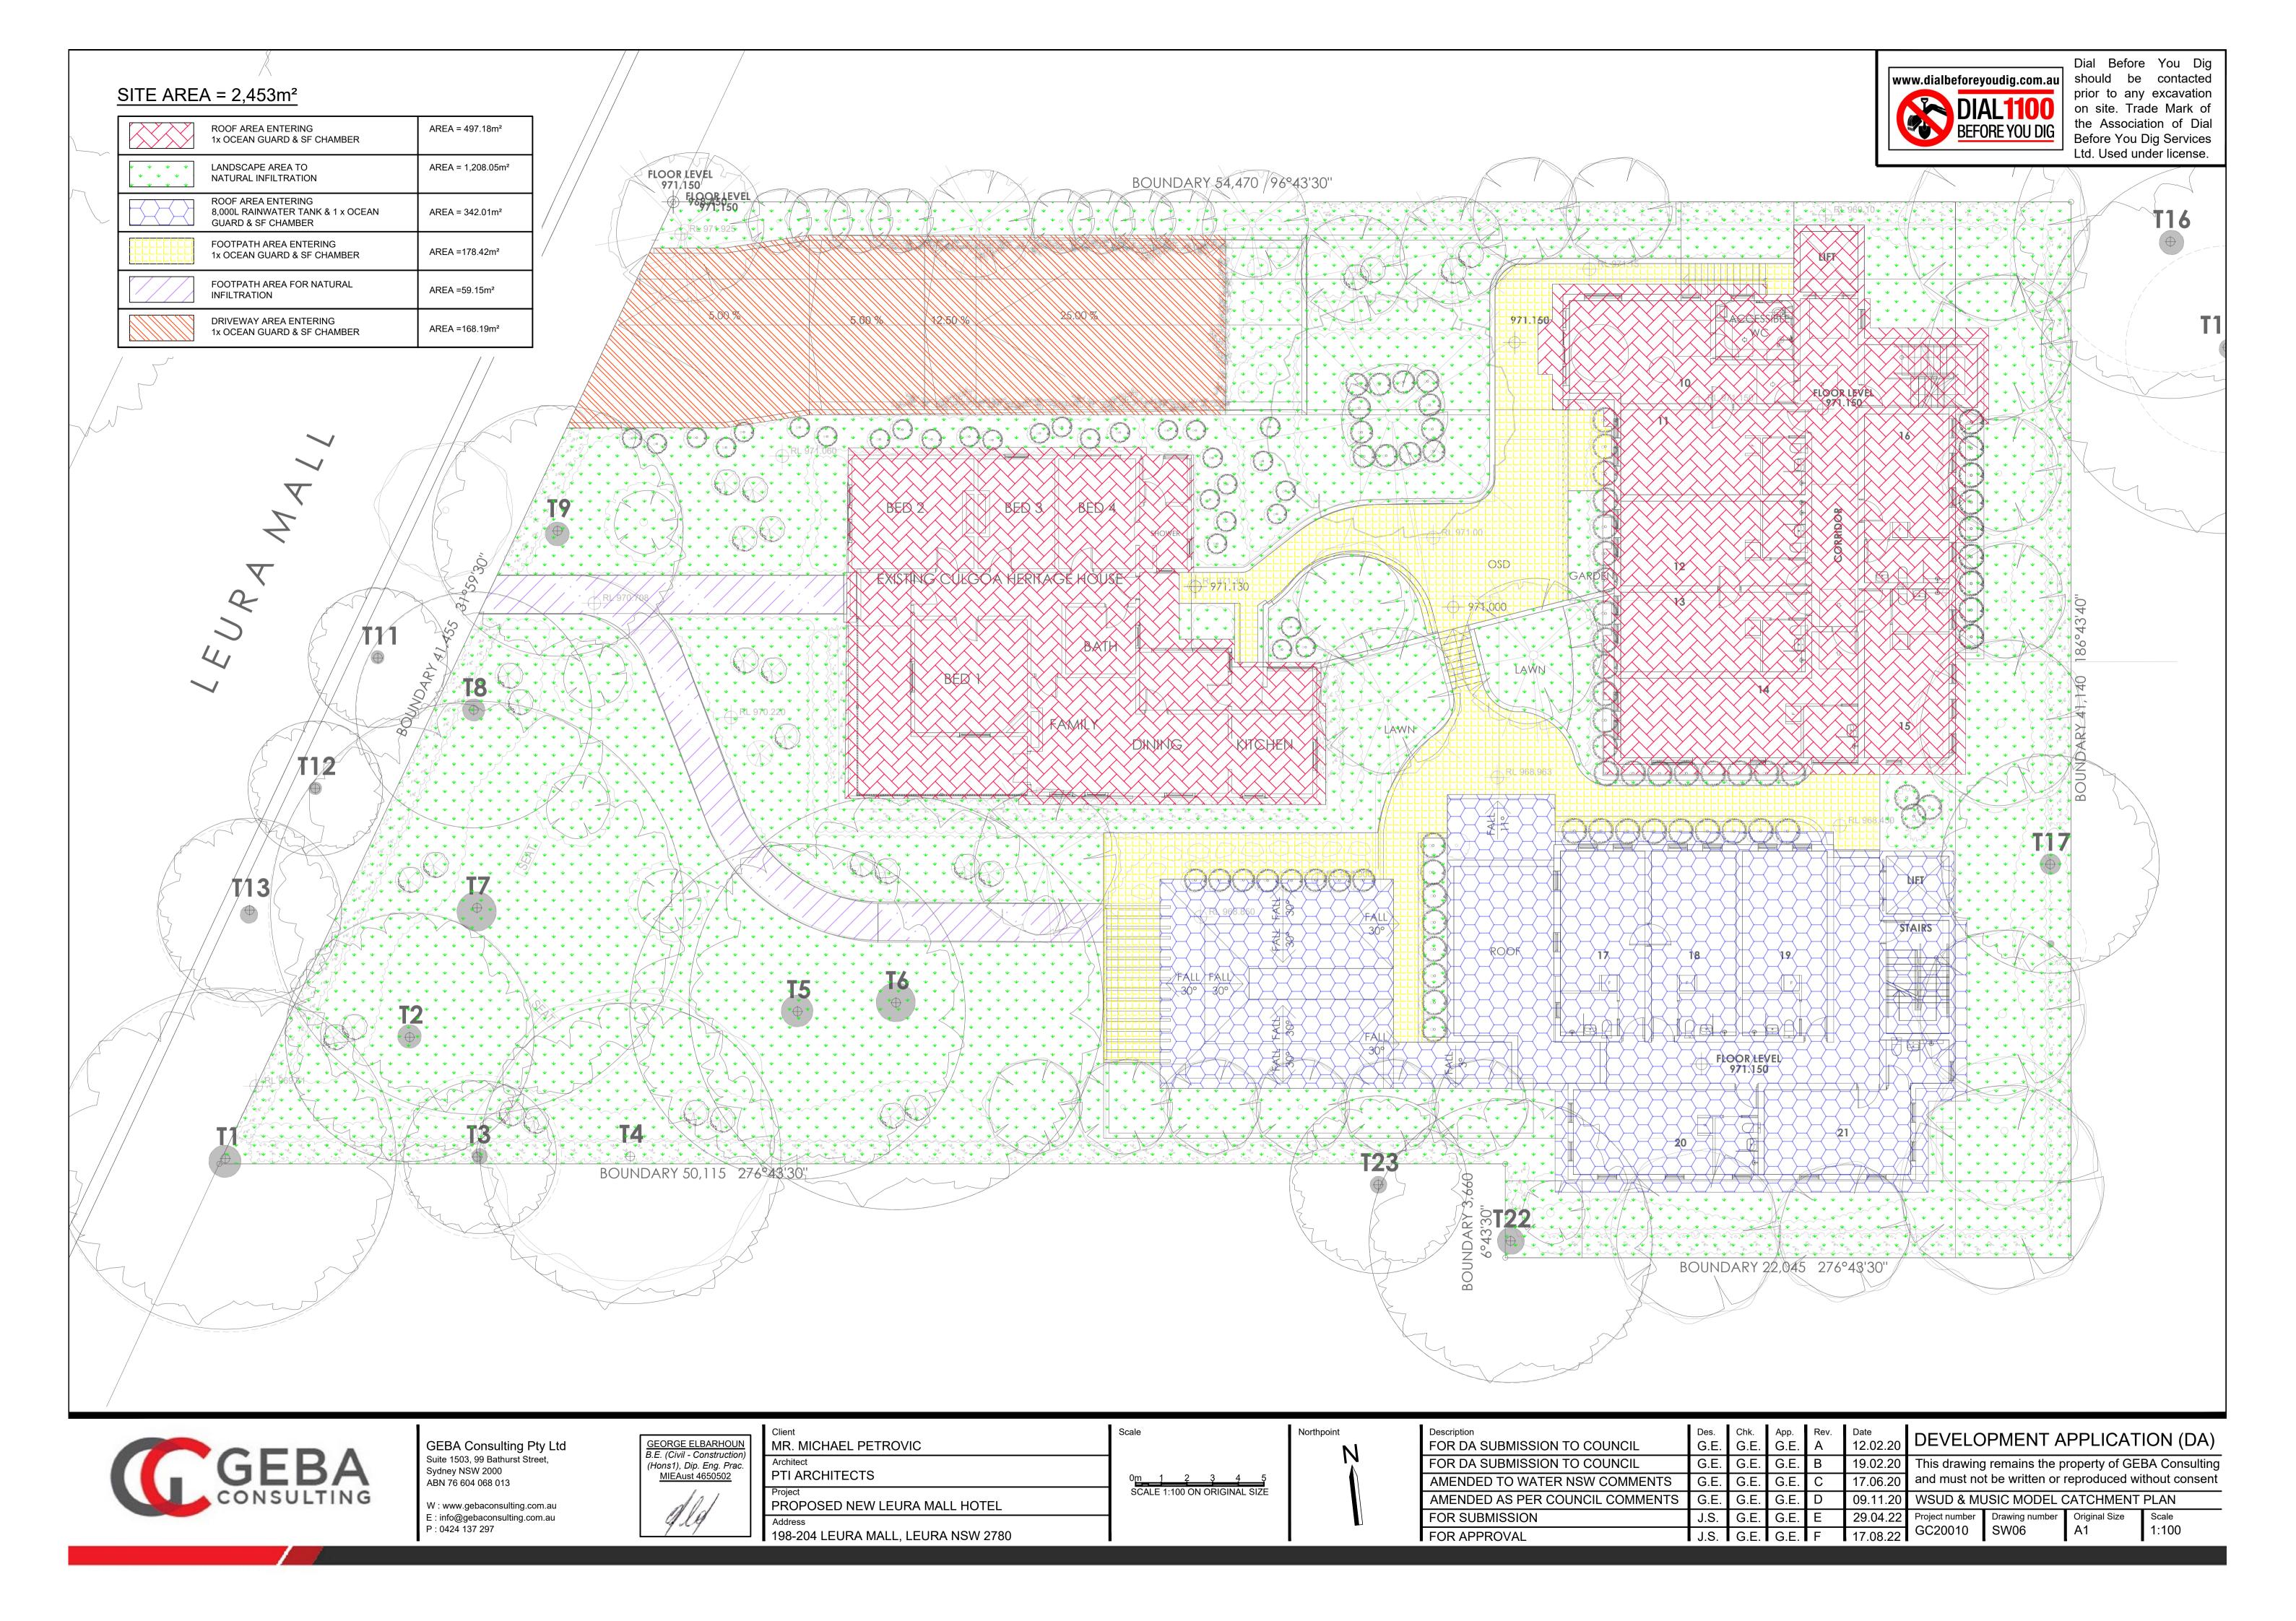



Dial Before You Dig should be contacted prior to any excavation on site. Trade Mark of the Association of Dial Before You Dig Services Ltd. Used under license.

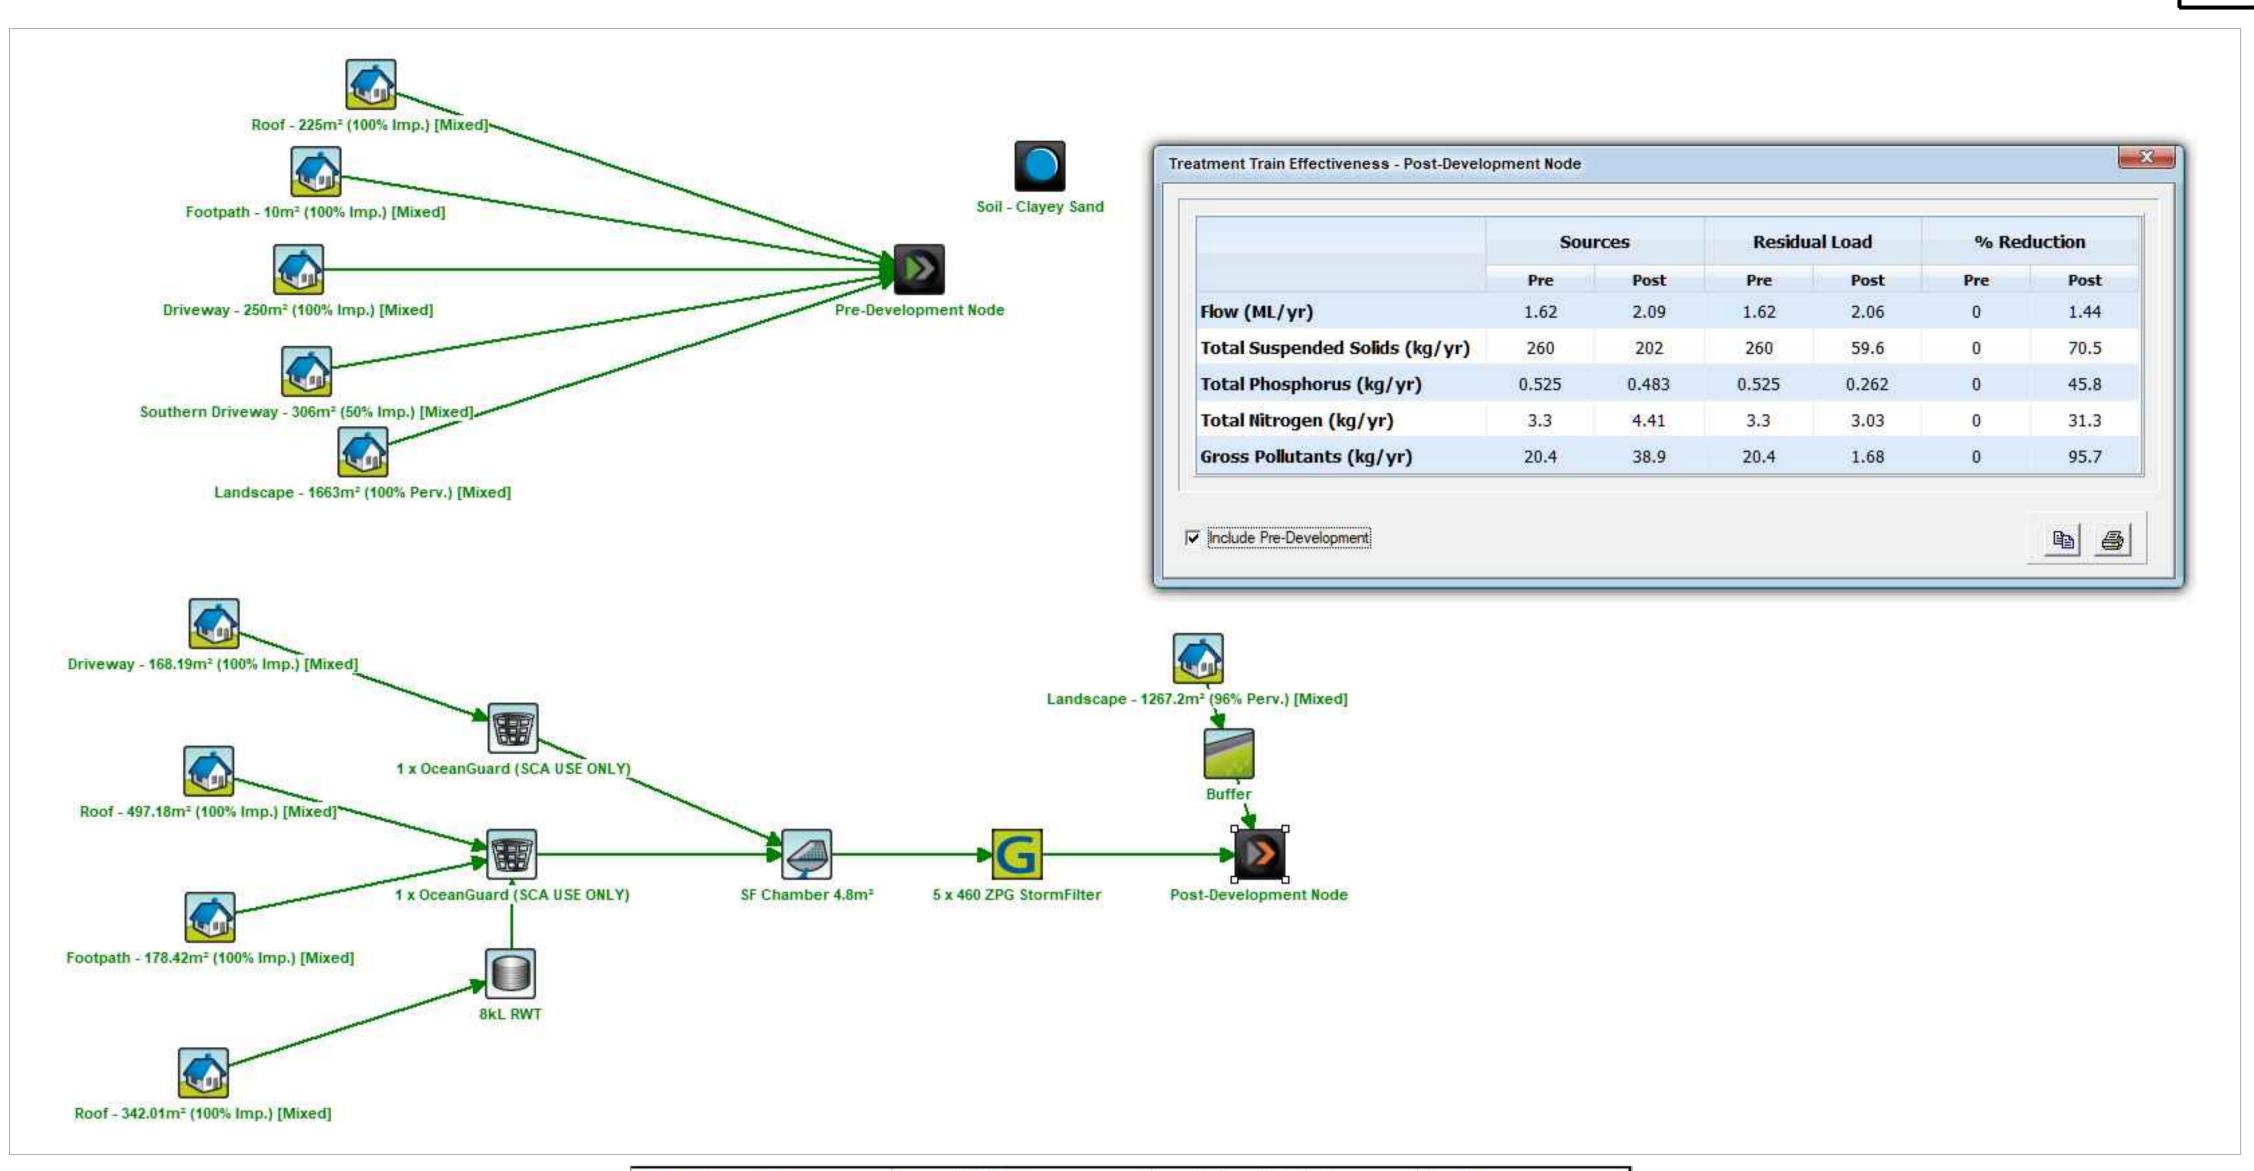


Pre-Development	Source (kg/yr)	Residual Load (kg/yr)	% Reduction
Flow (ML/yr)	1.62E+00	1.62E+00	0
Total Suspended Solids (kg/yr)	260	260	0
Total Phosphorus (kg/yr)	5.25E-01	5.25E-01	0
Total Nitrogen (kg/yr)	3.30E+00	3.30E+00	0
Gross Pollutants (kg/yr)	20.4	20.4	0
Post-Development	Source (kg/yr)	Residual Load (kg/yr)	% Reduction
Flow (ML/yr)	2.09E+00	2.06E+00	1.2
Total Suspended Solids (kg/yr)	2.02E+02	59.6	70.5
Total Phosphorus (kg/yr)	4.83E-01	2.62E-01	45.9
Total Nitrogen (kg/yr)	4.41	3.03	31.2
Gross Pollutants (kg/yr)	38.9	1.68E+00	95.7
NorBE	Pre-Development Load (kg/yr)	Post Development Load (kg/yr)	% Pre. Vs Post Reduction
Flow (ML/yr)	1.62	2.06	-27.2%
Total Suspended Solids (kg/yr)	2.60E+02	59.6	77.1%
Total Phosphorus (kg/yr)	0.525	0.262	50.1%
Total Nitrogen (kg/yr)	3.3	3.03	8.2%
Gross Pollutants (kg/yr)	20.4	1.68	91.8%




GEBA Consulting Pty Ltd Suite 1503, 99 Bathurst Street, Sydney NSW 2000 ABN 76 604 068 013

W : www.gebaconsulting.com.au
E : info@gebaconsulting.com.au
P : 0424 137 297

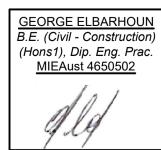


֖֖֖֡֞֞֜֜֞֓֓֓֟֟֝֟֟֓֓֓֟֟֓֓֓֓֟֟֓֓֓֓֓֓֟֓֓֓֟֓֓֓֟֓֓֓֟֓	Client MR. MICHAEL PETROVIC	8
	Architect PTI ARCHITECTS	
	Project PROPOSED NEW LEURA MALL HOTEL	
	Address 198-204 LEURA MALL, LEURA NSW 2780	

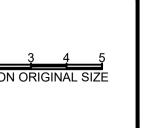

Description	Des.	Chk. G.E.	Арр.	Rev.	Date
FOR DA SUBMISSION TO COUNCIL	G.E.	G.E.	G.E.	Α	12.02.20
FOR DA SUBMISSION TO COUNCIL	G.E.	G.E.	G.E.	В	19.02.20
AMENDED TO WATER NSW COMMENTS	G.E.	G.E.	G.E.	С	17.06.20
AMENDED AS PER COUNCIL COMMENTS	G.E.	G.E.	G.E.	D	09.11.20
FOR SUBMISSION	J.S.	G.E.	G.E.	Ε	29.04.22
FOR APPROVAL	J.S.	G.E.	G.E.	F	17.08.22

20	DEVELOPMENT APPLICATION (DA)							
20	This drawing remains the property of GEBA Consulting							
20	and must not be written or reproduced without consent							
20	WSUD & MUSIC MODEL RESULTS							
22	Project number			Scale 1:100				
22	GC20010 SW07		A1	1:100				

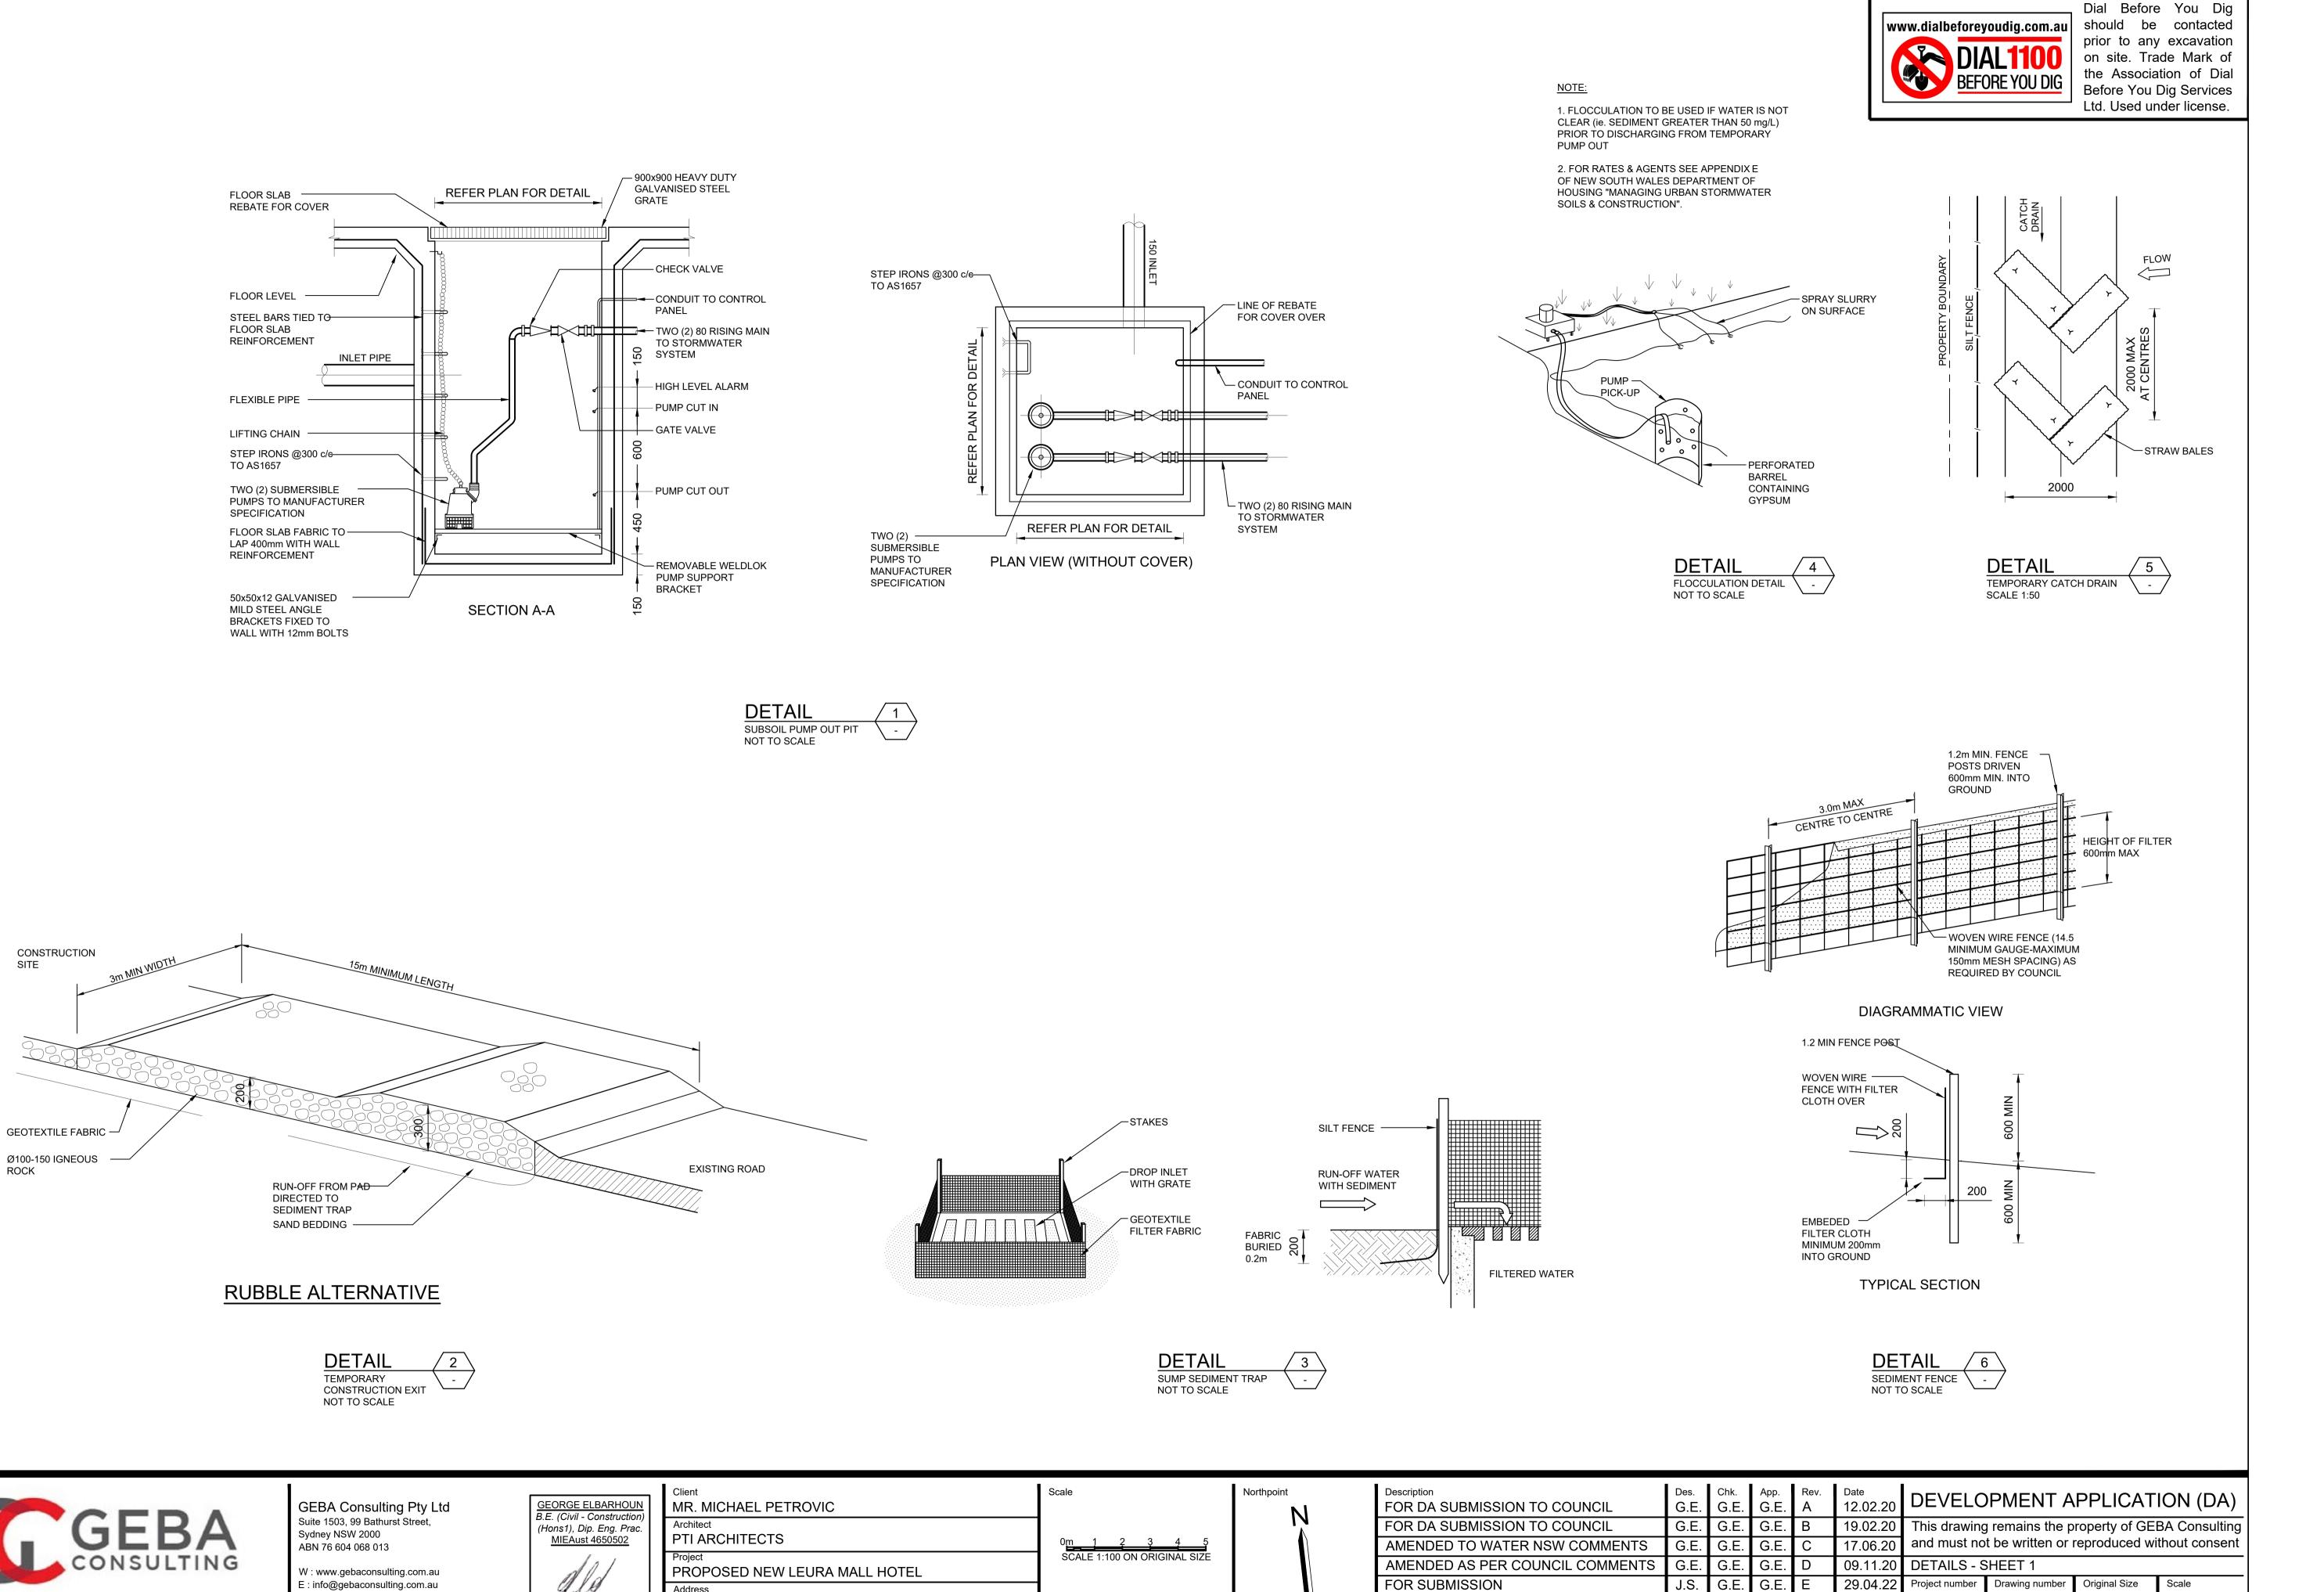

FOR APPROVAL

GC20010 SW08

1:100


ROCK

P: 0424 137 297

198-204 LEURA MALL, LEURA NSW 2780




Dial Before You Dig should be contacted prior to any excavation on site. Trade Mark of the Association of Dial Before You Dig Services Ltd. Used under license.

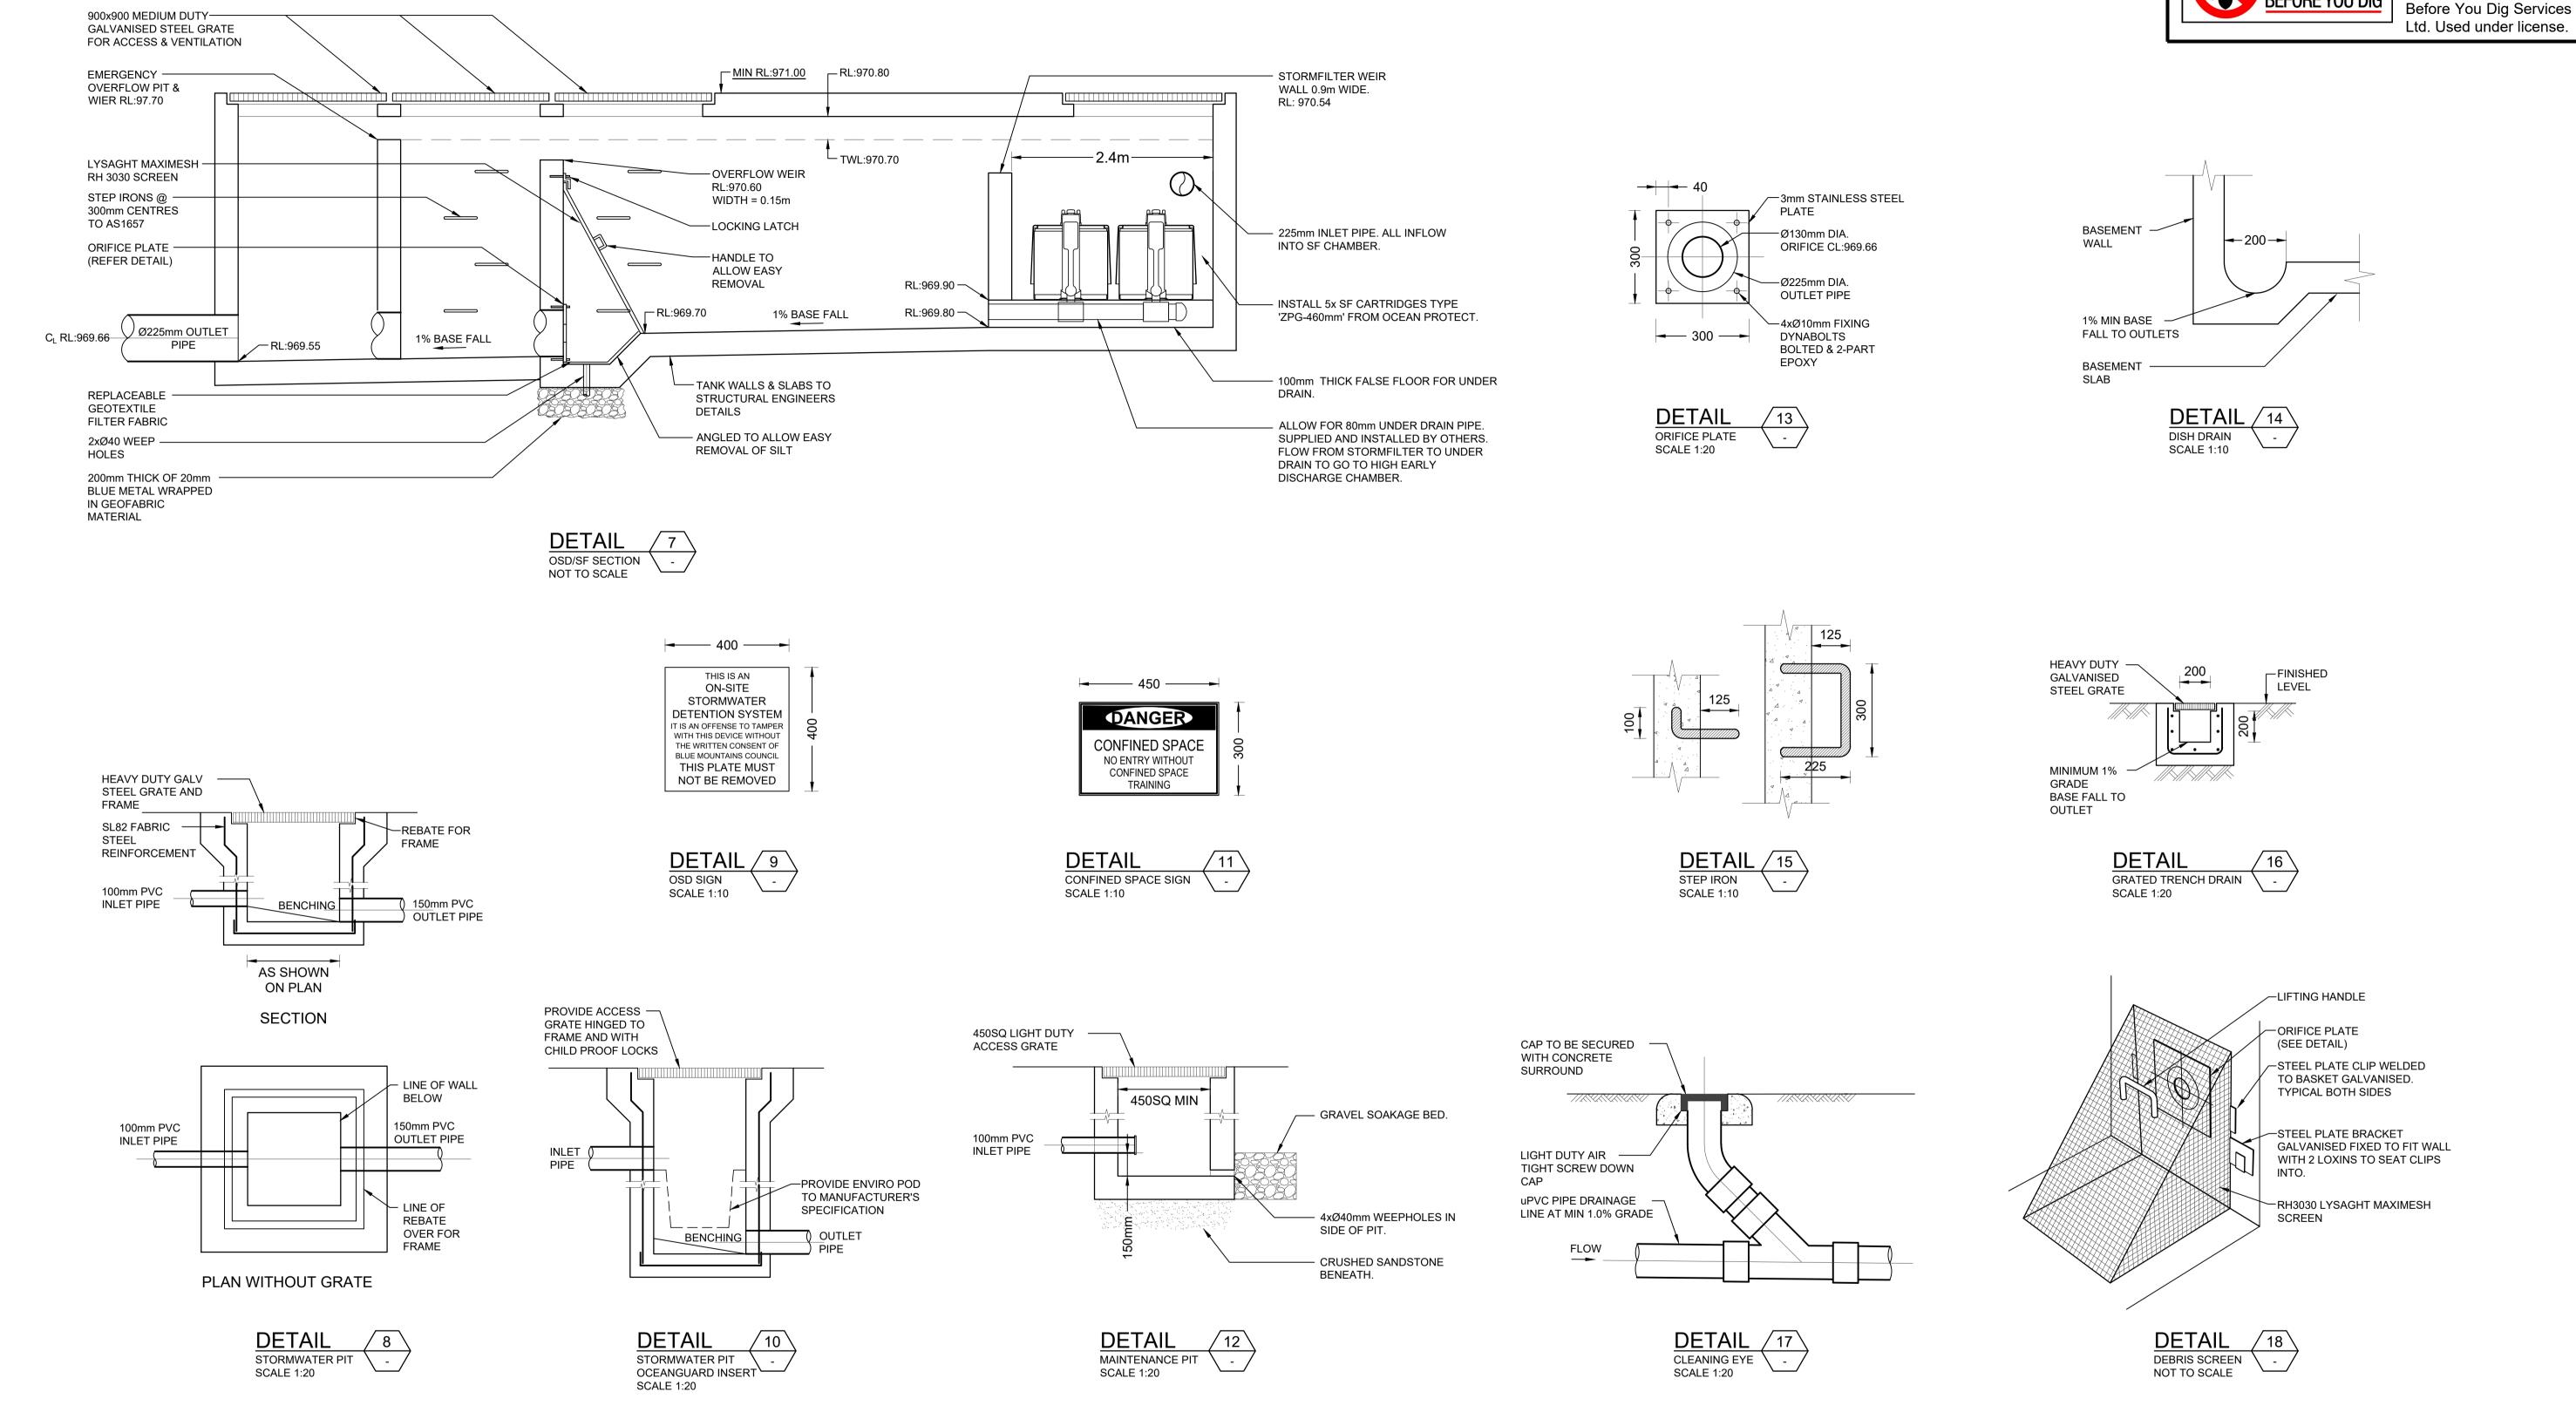


CEDA
. GEBA
CONSULTING

GEBA Consulting Pty Ltd Suite 1503, 99 Bathurst Street, Sydney NSW 2000 ABN 76 604 068 013

W : www.gebaconsulting.com.au E : info@gebaconsulting.com.au P : 0424 137 297

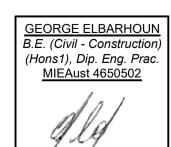

]	Client MR. MICHAEL PETROVIC
	Architect PTI ARCHITECTS
	Project PROPOSED NEW LEURA MALL HOTEL
	Address 198-204 LEURA MALL, LEURA NSW 2780

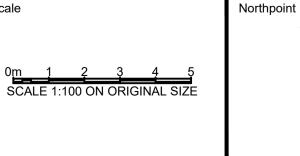

Description	Des.	Chk.	Арр.	Rev.	Date	DEVELOPMENT APPLICATION (DA)			
FOR DA SUBMISSION TO COUNCIL	G.E.	G.E.	G.E.	Α	12.02.20	DEVELOPMENT APPLICATION (DA)			
FOR DA SUBMISSION TO COUNCIL	G.E.	G.E.	G.E.	В	19.02.20	This drawing remains the property of GEBA Consulting			
AMENDED TO WATER NSW COMMENTS	G.E.	G.E.	G.E.	С	17.06.20	and must not be written or reproduced without consent			
AMENDED AS PER COUNCIL COMMENTS	G.E.	G.E.	G.E.	D	09.11.20	DETAILS - SHEET 2			
FOR SUBMISSION	J.S.	G.E.	G.E.	Е	29.04.22	Project number	Drawing number	Original Size	Scale
FOR APPROVAL	J.S.	G.E.	G.E.	F	17.08.22	GC20010	SW09	A1	1:100